
## **CITY OF PLEASANTON**


PUBLIC WORKS DEPARTMENT, ENGINEERING DIVISION
VALLEY AVENUE SOUND WALLS REPAIR PROJECT (REBID) - CIP NO. 18437
REBID SET, SEPTERMBER 4, 2025

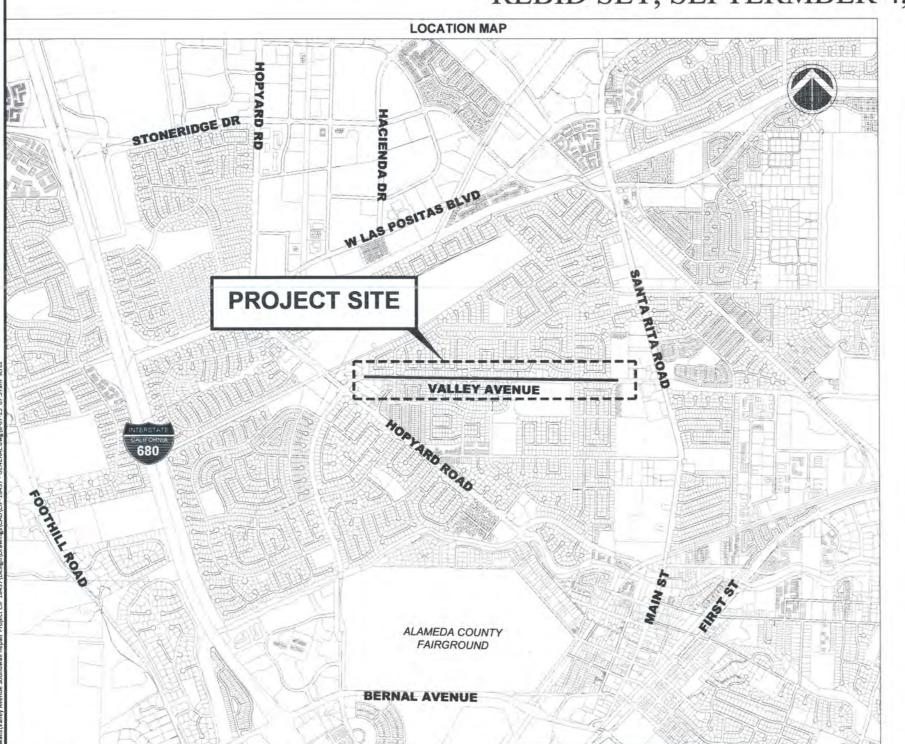

		SHEET INDEX	
SHEET NO.	DRAWING NO.	DESCRIPTION	
1	G-1	TITLE SHEET	
2	G-2	GENERAL NOTES	
3	G-3	POLLUTION PREVENTION PLAN	
4	C-1	UTILITY PLAN	
5	C-2	UTILITY PLAN	
6	S-1	PROJECT SPECIFICATIONS & NOTES	
7	S-2	DETAILS	
6 7		[ [	

	LEGEND
EXISTIN	G:
	SOUND WALL
#	DRAINAGE INLET
— ATT —	AT&T UTILITIES
— com —	COMMUNICATION UTILITIES
- LUMEN -	LEVEL 3 COMMUNICATION LINE
— E —	PG&E ELECTRIC LINE
— GAS —	PG&E GAS LINE
SD	STORM DRAIN LINE
ss	SANITARY SEWER LINE
— w —	WATER LINE
	RIGHT OF WAY

	ABBREVIATIONS	
AB	AGGREGATE BASE	
AC	ASPHALT CONCRETE	
COM	COMMUNICATION	
CONC	CONCRETE	
DET	DETAIL	
DR	DRIVE	
DWG	DRAWING	
EX	EXISTING	
MH	MANHOLE	
MIN	MINIMUM	
MAX	MAXIMUM	
OC	ON CENTER	
ST	STREET	
SS	SANITARY SEWER	
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**	INCH	
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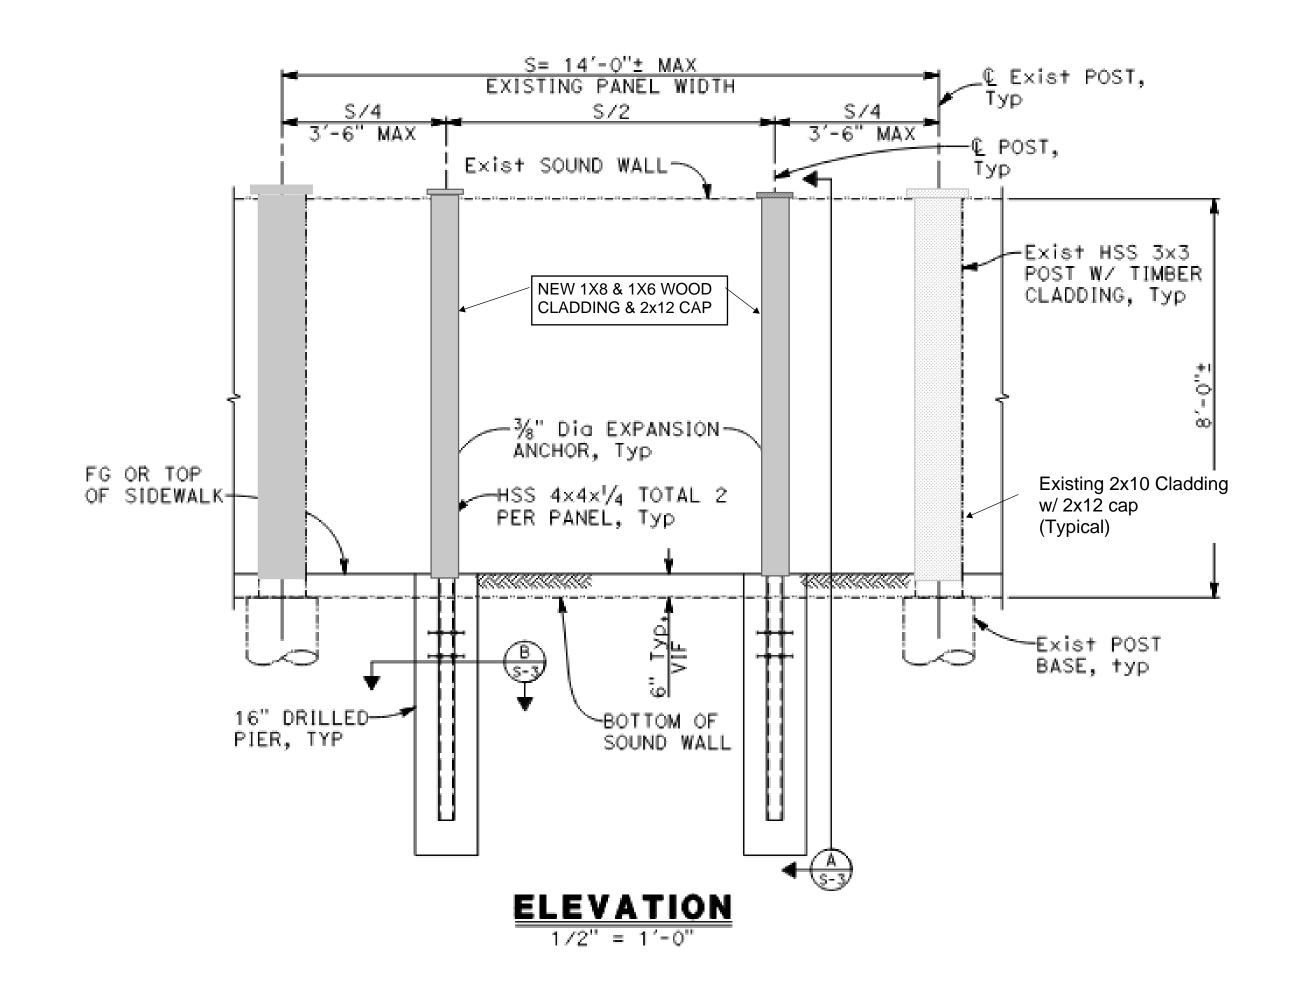
CITY OF PLEASANTON PUBLIC WORKS DEPARTMENT

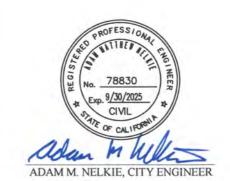
ADAM M. NELKIE CITY ENGINEER NO. 78830 EXP. 9/30/25

VALLEY	AVENUE SO	DUNDWALL	REPAIR	PROJECT	(REBID)
	TITL	E SHEET			

DESIGN:	AN	SCALE: NTS	D
DRAWN:	SN	PROJECT NO.: CIP-18437	
CHECKED	AN	N	
RAFFIC ENGINEER:	MT	DATE: July 24, 2025	1

- 3. THE OFFICE OF PUBLIC WORKS INSPECTION (925-931-5690) SHALL BE NOTIFIED 24 HOURS PRIOR TO THE START OF ANY WORK BY THE CONTRACTOR OR SUBCONTRACTORS.
- 4. IT SHALL BE THE CONTRACTOR'S RESPONSIBILITY TO DETERMINE THE EXISTENCE AND LOCATION OF ALL UNDERGROUND UTILITIES. THE CONTRACTOR SHALL NOTIFY UTILITY COMPANIES 48 HOURS PRIOR TO CONSTRUCTION TO FIELD LOCATE UTILITIES. CONTACT UNDERGROUND SERVICE ALERT AT 800-642-2444. ANY ADDED COST ON THE PART OF THE CONTRACTOR AS A RESULT OF THE ACTUAL LOCATION OF EXISTING UTILITIES BEING DIFFERENT FROM THOSE SHOWN ON THE PLANS SHALL BE BORNE BY THE CONTRACTOR AND ASSUMED INCLUDED IN THE CONTRACT UNIT PRICE.
- 5. THE CONTRACTOR SHALL BE HELD RESPONSIBLE FOR ANY FIELD CHANGES MADE WITHOUT WRITTEN AUTHORIZATION FROM THE CITY ENGINEER.
- CONTRACTOR SHALL PROVIDE TRAFFIC AND PEDESTRIAN CONTROL INCLUDING FLAG PERSONS PER SPECIFICATIONS AND SHALL SUBMIT A TRAFFIC CONTROL PLAN SUBJECT TO THE APPROVAL OF THE CITY ENGINEER PRIOR TO THE START OF WORK.
- 7. ALL EXISTING UTILITIES AND PRIVATE IMPROVEMENTS THAT BECOME DAMAGED DURING CONSTRUCTION SHALL BE COMPLETELY RESTORED TO THE SATISFACTION OF THE CITY ENGINEER, AT CONTRACTOR'S SOLE EXPENSE.
- 8. SAFETY MEASURES: AT ALL TIMES THE CONTRACTOR SHALL BE SOLELY AND COMPLETELY RESPONSIBLE FOR CONDITIONS OF THE JOB SITE INCLUDING SAFETY OF PERSONS AND PROPERTY, (THIS REQUIREMENT SHALL APPLY CONTINUOUSLY AND NOT JUST DURING NORMAL WORKING HOURS) AND FOR ALL NECESSARY INDEPENDENT ENGINEERING REVIEWS OF THESE CONDITIONS. THE ENGINEER'S JOB SITE REVIEW IS NOT INTENDED TO INCLUDE REVIEW OF THE ADEQUACY OF THE CONTRACTOR'S SAFETY MEASURES.
- 9. THE CONTRACTOR SHALL PREPARE AND DISTRIBUTE A "GOOD NEIGHBOR LETTER" ADVISING EACH RESIDENCE & BUSINESS 48 HOURS PRIOR TO BEGINNING THE WORK.
- 10. REFERENCE TO THE STATE STANDARD SPECIFICATIONS AND STANDARD PLANS MEANS THE MAY 2015 EDITIONS.
- 11. CONTRACTOR SHALL REMOVE ALL U.S.A. MARKINGS.
- 12. BACKGROUND AERIAL PROVIDED ON THE PROJECT PLANS IS FOR INFORMATION PURPOSES ONLY.
- 13. HAUL ROUTE: (AS APPROVED BY THE PROJECT INSPECTOR).
- 14. SOUND WALLS SHOWN ON PLANS ARE APPROXIMATE IN LOCATION.



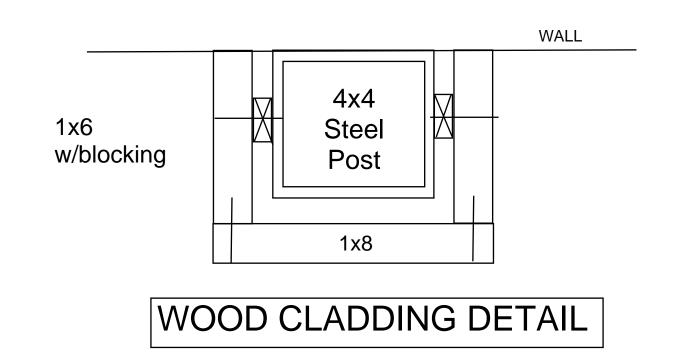



REV.	DATE	DESCRIPTION	THE CITY OF
		REBID SET	
			PLEASANTON

CITY OF PLEASANTON PUBLIC WORKS DEPARTMENT ADAM M. NELKIE CITY ENGINEER NO. 78830 EXP. 9/30/25

VALLEY AVENUE SOUNDWALL REPAIR PROJECT (REBID)

DESIGN: AN SCALE: DRAWN: CHECKED: TRAFFIC ENGINEER:


DWG NO. PROJECT NO.: CIP-18437 DATE: May 11, 2025

GENERAL NOTES

# Pollution Prevention - It's Part of the Plan



Runoff from streets and other paved areas are a major source of pollution in San Francisco Bay. Construction activities can directly affect the health of the Bay unless contractors and crews plan ahead to keep dirt, debris, and other construction waste away from strom drains and local creeks. Following these guidelines will ensure your compliance with the City of Pleasanton requirements. Contact the City of Pleasanton, Department of Engineering at (925) 931-5650, or for private onsite work, please contact the Building and Safety Division at (925) 931-5300.

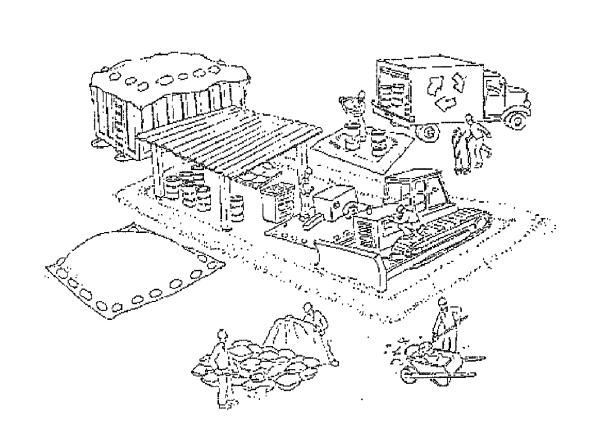

## Materials storage & spill cleanup

### Non-hazardous materials management

✓ Sand, dirt, and similar materials must be stored at least 10 feet from catch basins, and covered with a tarp during wet weather or when rain is forecast. Use (but don't overuse) reclaimed water for dust control as needed.

- > Sweep or vacuum streets and other paved areas daily. Do not wash down streets
- Recycle all asphalt, concrete, and aggregate base material from demolition
- Comply with City Ordinance for recycling construction materials, wood, gyp board,
- Contact Pleasanton Garbage Service at 925-846-2042 for both recycling and debris
- Check dumpsters regularly for leaks and to make sure they don't overflow. Repair or replace leaking dumpsters promptly.

### Hazardous materials management

- Label all hazardous materials and hazardous wastes (such as pesticides, paints, thinners, solvents, fuel, oil, and antifreeze) in accordance with city, state, and federal regulations.
- ✓ Store hazardous materials and wastes in secondary containment and cover them during wet weather.
- Follow manufacturer's application instructions for hazardous materials and be careful not to use more than necessary. Do not apply chemicals outdoors when rain is forecast within 24 hours.
- ✓ Be sure to arrange for appropriate disposal of all hazardous wastes.

### Spill prevention and control

- Keep a stockpile of spill cleanup materials (rags, absorbents, etc. ) available at the construction site at all times.
- ✓ When spills or leaks occur, contain them immediately and be particularly careful to prevent leaks and spills from reaching the gutter, street, or storm drain.
- Never wash spilled material into a gutter, street, storm drain, or creek!
- Report any hazardous materials spills immediately! Dial 911 or the Livermore/Pleasanton Fire Department at 925-454-2330.


## Vehicle and equipment maintenance & cleaning

- Inspect vehicles and equipment for leaks
- frequently. Use drip pans to catch leaks until repairs are made; repair leaks
- Fuel and maintain vehicles on site only in a bermed area or over a drip pan that is big enough to prevent runoff.
- ✓ If you must clean vehicles or equipment on site, clean with water only in a
- bermed area that will not allow
- rinse water to run into gutters, streets,
- storm drains, or creeks.
- ✓ Do not clean vehicles or equipment on—site using soaps, solvents, degreasers, steam cleaning equipment, etc.



Keep excavated soil on the site where it is least likely to collect in the street.

Transfer to dump trucks should take place on the site, not in the street. Use fiber rolls, silt fences, or other control measures to minimize the flow of silt off the site. See the approved erosion control plan for this site.

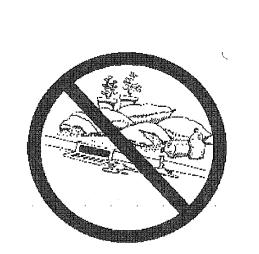

Earth moving activities are only allowed during dry weather by permit and as approved by the City Inspector in the Field.

Mature vegetation is the best form of erosion control. Minimize disturbance to existing vegetation whenever possible. ✓ If you disturb a slope during construction, prevent erosion by securing the soil with erosion control fabric, or seed with fastgrowing grasses as soon as possible. Place fiber rolls down-slope until soil is secure.

✓If you suspect contamination (from site history, discoloration, odor, texture, abandoned underground tanks or pipes, or buried debris), call Pleasanton/Livermore Fire Department at 925-454-2330 or the Regional Water Quality Control Board for help in determining what should be done, and manage disposal of contaminated soil according to their instuctions.

## Dewatering operations

- ✓ Reuse water for dust control, irrigation,
- or another on-site purpose to the greatest extent possible.
- ✓ Be sure to call Pleasanton's storm drain source control inspector, Brian Lorimer, before discharging water to a
- street, gutter, or storm drain (925-931-5511). Filtration or diversion through a basin, tank, or sediment trap may be required.
- ✓ In areas of known contamination, testing is required prior to reuse or discharge of groundwater. Consult with the city inspector to determine what testing is required and how to interpret results. Contaminated groundwater must be treated or hauled off-site for proper disposal

## Saw cutting

Always completely cover or barricade storm drain inlets when saw cutting. Use

filter fabric, catch basin inlet filters, or sand/gravel bags to keep slurry out of the storm drain system.

✓ Shovel, absorb, or vacuum saw—cut slurry and pick up all waste as soon as you are finished in one location or at the end of each work day (whichever is

If saw cut slurry enters a catch basin, clean it up immediately.

## Paving/asphalt work

- ✓ Do not pave during wet weather or when rain is forecast.
- ✓ Always cover storm drain inlets and manholes when paving or applying seal coat, tack coat, slurry seal, or fog seal. Place drip pans or absorbent material under paving equipment when not in use. Protect gutters, ditches, and drainage courses with sand/gravel bags, or earthen
- ✓ Do not sweep or wash down excess sand from sand sealing into gutters, storm drains, or creeks. Collect sand and return it to the stockpile, or dispose of it as trash
- ✓ Do not use water to wash down fresh asphalt concrete pavement.

## Concrete, grout, and mortar storage & waste disposal

∠Be sure to store concrete, grout, and mortar under cover and away from drainage areas. These materials must never reach a

✓ Wash out concrete equipment/trucks off—site or designate an on-site area for washing where water will flow onto dirt or into a temporary pit in a dirt area. Let the water seep into the soil and dispose of hardened concrete with trash.



exposed aggregate concrete to a dirt area where it will not run into a gutter, street, or storm drain. ✓ If a suitable dirt area is not available, collect the wash water and remove it for appropriate disposal off site.

✓ Divert water from washing

### Painting

- ✓ Never rinse paint brushes or materials in a gutter or street! ✓ Paint out excess water-based paint before rinsing brushes, rollers, or containers in a sink.
- If you can't use a sink, direct wash water to a dirt area and spade it in.
- ✓ Paint out excess oil-based paint before cleaning brushes
- Filter paint thinners and solvents for reuse whenever possible. Dispose of oil-based paint sludge and unusable thinner as hazardous waste.




For more detailed information: Get a copy of the "Field Manual" -- (510) 622-2465 or www.abag.ca.gov/bayarea/sfep/reports/construction.html

# Storm drain polluters maybe liable for fines of \$10,000 or more per day!

Bay Area Stormwater Management Agencies Association (BASMAA) 1–888-BAYWISE

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CITY OF PLEASANTON PUBLIC WORKS DEPARTMENT ADAM M. NELKIE CITY ENGINEER NO. 78830 EXP. 9/30/25

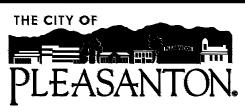
VALLEY AVENUE SOUNDWALL REPAIR PROJECT (REBID)


POLLUTION PREVENTION PLAN

DESIGN: ANDRAWN: CHECKED: TRAFFIC ENGINEER: MT


SCALE: PROJECT NO.: CIP-18437 DATE: July 24, 2025

DWG NO. G-33 OF 7

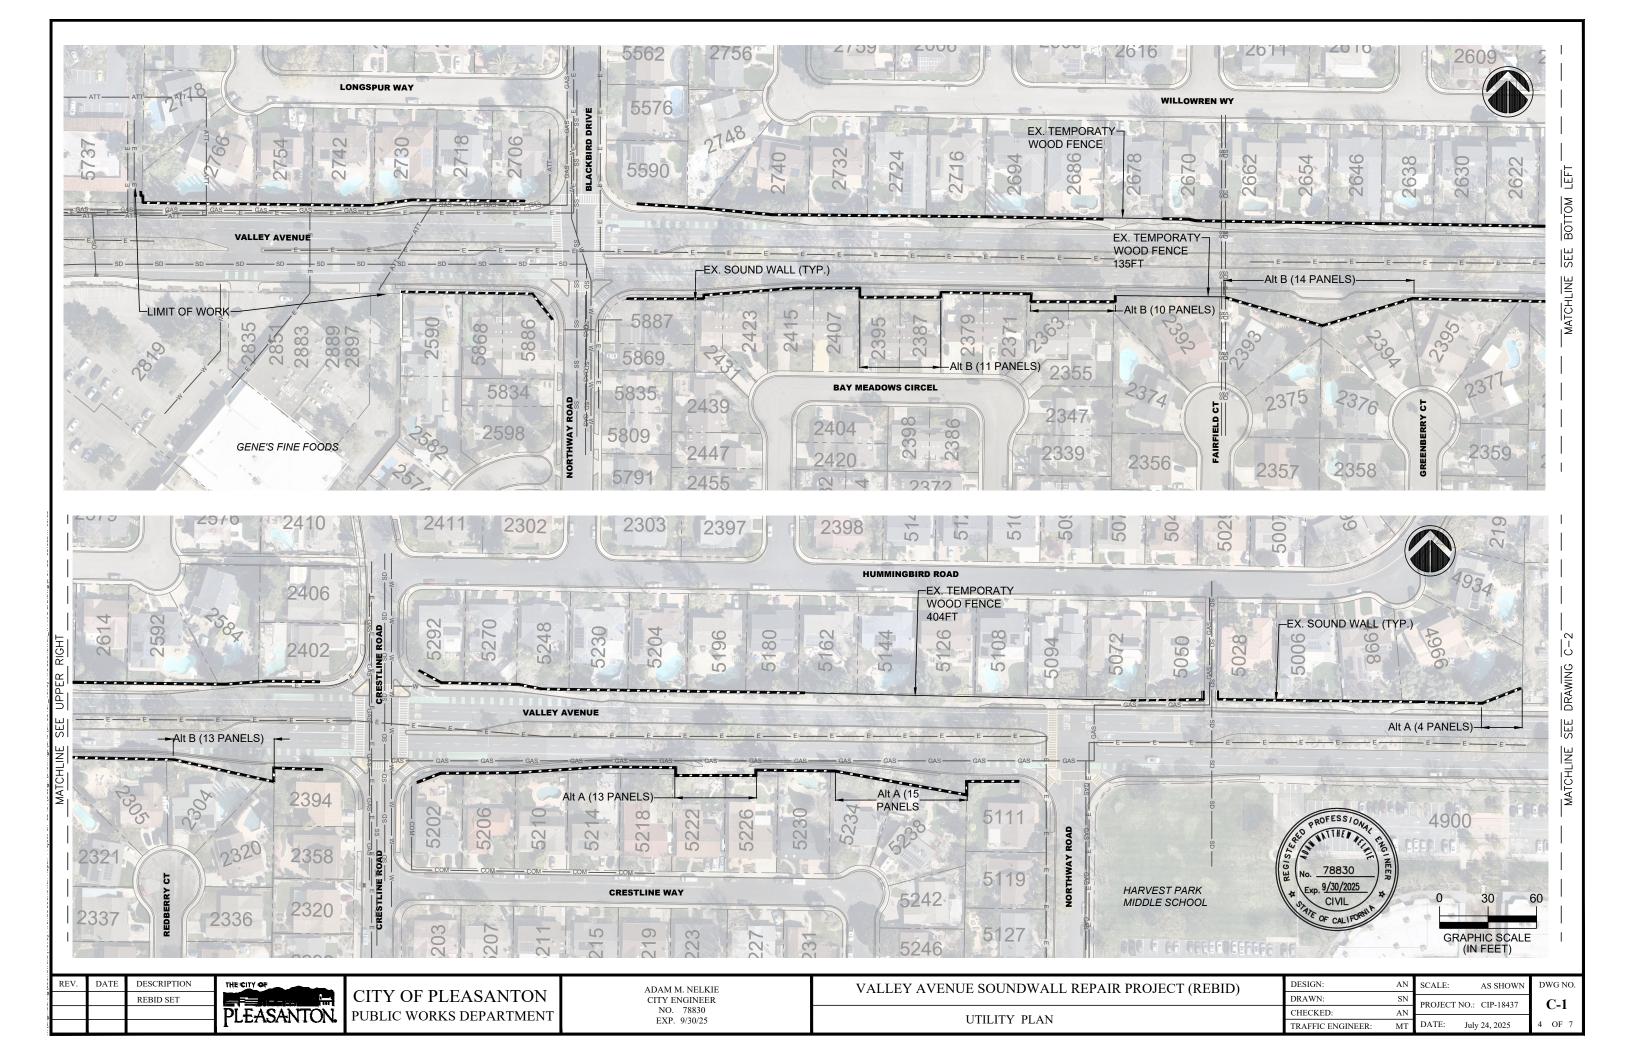

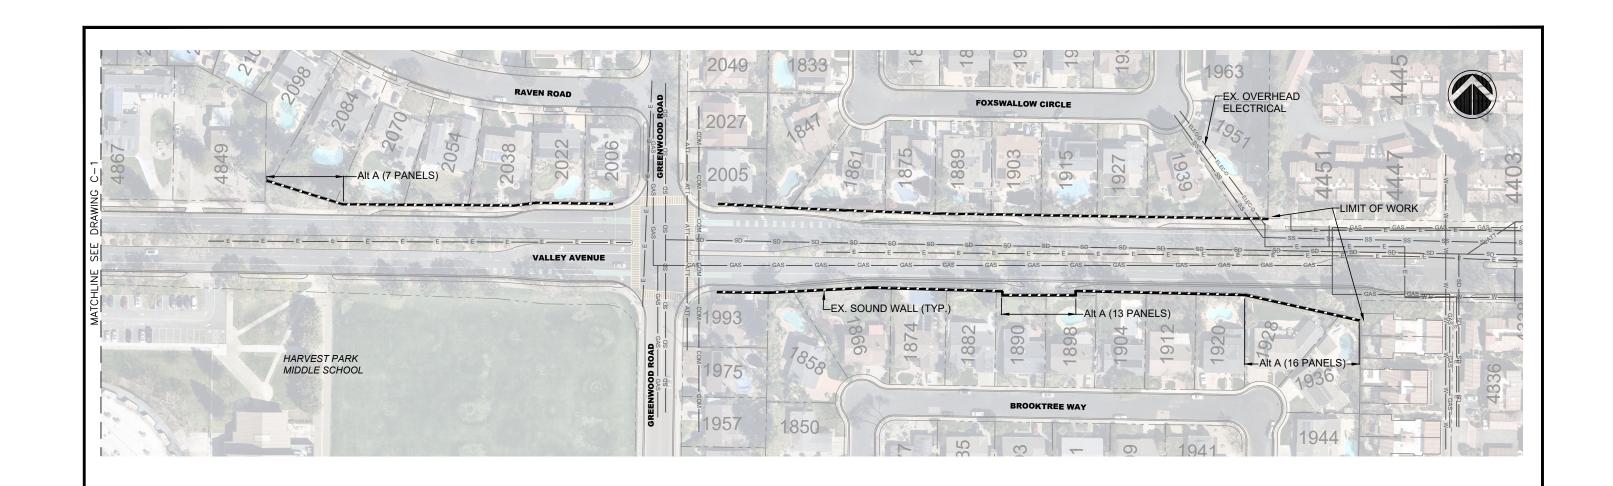



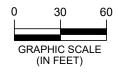

REV.	DATE	DESCRIPTION REBID SET	THE CITY OF	CITY OF PLEASANTON	ADAM M. NELKIE CITY ENGINEER	VALLEY AVENUE SOUNDWALL REPAIR PROJECT (REBID)	DESIGN: ANDRAWN: SN	SCALE: AS SHOWN	DWG NO.
\Enginee			PLEASANTON.	PUBLIC WORKS DEPARTMENT		UTILITY PLAN	CHECKED: AN TRAFFIC ENGINEER: MT	PROJECT NO.: CIP-18437  DATE: July 24, 2025	5 OF 7

DIAMETER

LAG SCREW(S)

LIVE LOAD

- THE 2022 STATE OF CALIFORNIA STANDARD SPECIFICATIONS.

2. DESIGN DATA:

V = 90 MPHRISK CATEGORY 1, EXPOSURE B

P = 16 psf<u>SEISMIC:</u> P = 59 psf FOR NEW PANELS

P = 45 psf FOR EXISTING PANELSSs = 2.09qS1 = 0.86gSITE CLASS = DSds = 1.34g

LATERAL SOIL BEARING PRESSURE 100 pcf

EXISTING SOUND WALL PANEL PANEL THICKNESS = 3" THICKNESS CONCRETE COMPRESSIVE STRENGTH = 2500 PSI

# SPECIAL INSPECTION

STRUCTURAL SPECIAL INSPECTION AND TESTING

GENERALSE PROVISIONS SHALL GOVERN THE QUALITY, WORKMANSHIP, AND REQUIREMENTS FOR WORK COVERED. MATERIALS OF CONSTRUCTION AND TESTS SHALL CONFORM TO THE APPLICABLE STANDARDS LISTED. THE CONTRACTOR SHALL PROVIDE A MINIMUM 48 HOUR NOTICE TO THE SPECIAL INSPECTION AGENCY FOR WORK THAT REQUIRES SPECIAL INSPECTION. THE CONTRACTOR SHALL PROVIDE THE SPECIAL INSPECTOR WITH THE USE OF A LIFT OR OTHER EQUIPMENT AS REQUIRED TO ALLOW ACCESS TO THE WORK THAT REQUIRES INSPECTION. THE CONTRACTOR SHALL PROVIDE THE SPECIAL INSPECTOR ACCESS TO THE APPROVED PLANS AND SPECIFICATIONS AND RETAIN SPECIAL INSPECTION RECORDS AT THE JOB-SITE.

PRECONSTRUCTION MEETING A PRECONSTRUCTION MEETING THAT INCLUDES PROJECT SUPERINTENDENT, INSPECTOR & ENGINEER IS REQUIRED. MEETING MINUTES MUST BE REVIEWED & APPROVED BY THE ENGINEER OF RECORD PRIOR TO BEGINNING WORK.

DEFINITIONS CONTINUOUS SPECIAL INSPECTION: THE FULL-TIME OBSERVATION OF WORK REQUIRING SPECIAL INSPECTION BY AN APPROVED SPECIAL INSPECTOR WHO IS PRESENT IN THE AREA WHERE THE WORK IS BEING PERFORMED. PERIODIC SPECIAL INSPECTION: THE PART-TIME OR INTERMITTENT

OBSERVATION OF WORK REQUIRING SPECIAL INSPECTION BY AN APPROVED SPECIAL INSPECTOR WHO IS PRESENT IN THE AREA WHERE THE WORK HAS BEEN OR IS BEING PERFORMED AND AT THE COMPLETION OF THE WORK.

REFERENCE STANDARDS (EDITIONS ADOPTED BY CURRENT GOVERNING CALIFORNIA BUILDING CODE) - CBC - CALIFORNIA BUILDING CODE 2022 AND ALL STANDARDS REFERENCED BY

- AISC 360 - SPECIFICATION FOR STRUCTURAL STEEL BUILDINGS; AMERICAN INSTITUTE OF STEEL CONSTRUCTION INC

- ACI 318 - BUILDING CODE REQUIREMENTS FOR STRUCTURAL CONCRETE AND

COMMENTARY; AMERICAN CONCRETE INSTITUTE ASTM — ASTM INTERNATIONAL

REPORT REQUIREMENTS

SCHEDULE OF STRUCTURAL INSPECTION AND TESTING

SPECIAL INSPECTORS SHALL KEEP RECORDS OF INSPECTIONS, AND SHALL FURNISH INSPECTION REPORTS TO THE BUILDING OFFICIAL AND TO THE REGISTERED DESIGN PROFESSIONAL IN RESPONSIBLE CHARGE. REPORTS SHALL INDICATE THAT THE WORK INSPECTED WAS OR WAS NOT COMPLETED IN CONFORMANCE TO THE APPROVED CONSTRUCTION DOCUMENTS. DISCREPANCIES SHALL BE BROUGHT TO THE IMMEDIATE ATTENTION OF THE CONTRACTOR FOR CORRECTION. IF THEY ARE NOT CORRECTED, THE DISCREPANCIES SHALL BE BROUGHT TO THE ATTENTION OF THE BUILDING OFFICIAL AND TO THE REGISTERED DESIGN PROFESSIONAL IN RESPONSIBLE CHARGE PRIOR TO THE COMPLETION OF THAT PHASE OF THE WORK. A FINAL REPORT DOCUMENTING THE REQUIRED SPECIAL INSPECTIONS AND CORRECTION OF ANY DISCREPANCIES NOTED IN THE INSPECTIONS SHALL BE SUBMITTED AT A POINT IN TIME AGREED UPON PRIOR TO THE START OF THE WORK BY THE PERMIT APPLICANT AND THE BUILDING OFFICIAL.

CONSTRUCTION TYPE	REQUIRED SPECIAL INSPECTIONS	CONTINUOUS	PERIODIC
STRUCTURAL STEEL	CONFIRM IDENTIFICATION MARKINGS CONFORM TO ASTM STANDARDS SPECIFIED IN THE APPROVED CONSTRUCTION DOCUMENTS		X
	REVIEW MANUFACTURER'S CERTIFICATE OF COMPLIANCE INCLUDING CERTIFIED MATERIAL TEST REPORTS AND CERTIFICATIONS		х
	GALVANIZED STEEL MEMBERS AND ANCHOR ROD LAYOUT AND DIMENSIONS		Х
	VERIFY FINISH AND DIMENSIONAL TOLERANCE, AND PROTECTED ZONE RESTRICTIONS		X
POST-INSTALLED	ANCHOR/BAR TYPE, DIAMETER, LENGTH AND CLEANLINESS		Х
ANCHORS	HOLE LOCATION, DIAMETER, DEPTH AND CLEANLINESS		Х
	ANCHOR/BAR EMBEDMENT, SPACING AND EDGE DISTANCE		Х
	ADHERENCE TO MANUFACTURER'S PRINTED INSTALLATION INSTRUCTIONS		X
	ADHESIVE AND ANCHOR/BAR INSTALLATION PER ICC/IAPMO EVALUATION REPORT		Χ
	TIGHTENING TORQUE WITH CALIBRATED TORQUE WRENCH REACHING SPECIFIED TORQUE WITHIN A 1/2 TURN OF SEATING (IMPORTANT: VERIFY WITH ICC/IAPMO REPORT WHETHER MAXIMUM OR MINIMUM TORQUE)		X
CAST-IN-PLACE PILES (INSPECTIONS REQUIRED IN ADDITION TO THOSE	DRILLING OPERATIONS AND MAINTAIN COMPLETE AND ACCURATE RECORDS FOR EACH ELEMENT		Х
REQUIRED FOR CONCRETE OR STEEL) - CBC SECTION 1705.8	PLACEMENT LOCATIONS AND PLUMBNESS, CONFIRM ELEMENT DIAMETERS, BELL DIAMETERS (IF APPLICABLE) AND LENGTHS. RECORD CONCRETE OR GROUT VOLUMES.		х

CONCRETE MIN. 28 DAY MAX. SIZE MAX. SLUMP TOTAL AIR **ELEMENT** COMPRESSIVE AGGREGATE (INCHES) CONTENT STRENGTH (INCHES) (%) 3/4 POST PIER 2500 \_\_\_

SIDEWALK CONCRETE MUST CONFORM TO CITY STANDARDS

**EARTHWORK** 

EARTHWORK MUST CONFORM TO THE PROVISIONS IN SECTION 19, "EARTHWORK," OF THE 2022 STATE OF CALIFORNIA STANDARD SPECIFICATIONS.

STRUCTURAL STEEL

THE CONTRACTOR SHALL PROVIDE MILL CERTIFICATES FOR EACH GRADE OF STEEL. MILL CERTIFICATES SHALL INCLUDE NAME OF MILL, DATE OF ROLLING, DATE OF SHIPPING, ULTIMATE TENSILE STRENGTH, YIELD STRENGTH, AND PERCENT OF ELONGATION, MILL CERTIFICATES SHALL BE FURNISHED WITH EACH LOT OF MATERIAL SHIPPED TO THE SITE AND SHALL BE SIGNED BY THE CONTRACTOR WHICH WILL SERVE TO CERTIFY THAT ALL STRUCTURAL STEEL MATERIALS INSTALLED COMPLY WITH SPECIFIED REQUIREMENTS.

STRUCTURAL TUBING: ASTM A500, Grade C.

THREADED ROD AND NUTS: ASTM F1554 Gr, 36 MANUFACTURED TO AMERICAN STANDARD BOLT AND NUT DIMENSIONS.

WASHERS SHALL BE FLAT CIRCULAR AND SHALL CONFORM TO ASTM F844. WASHER FINISH SHALL MATCH NUT. **FABRICATION** 

THE FABRICATOR SHALL PROVIDE QUALITY CONTROL INSPECTIONS FOR WELDING SHOP FABRICATE TO GREATEST EXTENT POSSIBLE.

FINISH

GALVANIZING:

GALVANIZE ALL STEEL GALVANIZING OF PRODUCTS FABRICATED FROM ROLLED, PRESSED AND FORGED STEEL SHAPES, PLATES, BARS AND STRIP 1/8 INCH THICK OR THICKER, SHALL CONFORM TO ASTM A123

**OBSTRUCTIONS** 

ATTENTION IS DIRECTED TO SECTIONS 8-1.10, "UTILITY AND NON-HIGHWAY FACILITIES," AND 15, "EXISTING HIGHWAY FACILITIES," OF THE STANDARD SPECIFICATIONS AND THESE SPECIAL PROVISIONS.

THE CONTRACTOR'S ATTENTION IS DIRECTED TO THE EXISTENCE OF CERTAIN UNDERGROUND FACILITIES THAT MAY REQUIRE SPECIAL PRECAUTIONS BE TAKEN BY THE CONTRACTOR TO PROTECT THE HEALTH, SAFETY AND WELFARE OF WORKMEN AND OF

THE CONTRACTOR MUST NOTIFY THE ENGINEER AND THE APPROPRIATE REGIONAL NOTIFICATION CENTER FOR OPERATORS OF SUBSURFACE INSTALLATIONS AT LEAST 5 WORKING DAYS, BUT NOT MORE THAN 14 CALENDAR DAYS, PRIOR TO PERFORMING ANY EXCAVATION OR OTHER WORK CLOSE TO ANY UNDERGROUND PIPELINE, CONDUIT, DUCT, WIRE OR OTHER STRUCTURE. REGIONAL NOTIFICATION CENTERS INCLUDE BUT ARE NOT LIMITED TO THE FOLLOWING:

NOTIFICATION CENTER	TELEPHONE NUMBER
UNDERGROUND SERVICE	1-800-642-2444
ALERT—NORTHERN CALIFORNIA (USA)	1-800-227-2600
UNDERGROUND SERVICE	1-800-422-4133
ALERT—SOUTHERN CALIFORNIA (USA)	1-800-227-2600

### NUMBER LONG LEGS BACK TO BACK LONG LEG HORIZONTAL ANCHOR BOLT LLV LONG LEG VERTICAL APPROX APPROXIMATE(LY) LW LIGHT WEIGHT ARCH. ARCHITECT(URAL) MACHINE BOLT(S) BLOCK MAX MAXIMUM BLOCKING MECH MECHANICAL BUILDING BLDG MFR MANUFACTURER BEAM MIN MINIMUM BOUNDARY NAILING MISC MISCELLANEOUS ВОТТОМ BOT BOF BOTTOM OF FOOTING (N) BWBOTTOM OF WALL NOT IN CONTRACT NUMBER CENTER LINE NOM NOMINAL CALIFORNIA BLDG CODE NS NEAR SIDE CAST IN DRILLED HOLE NTS NOT TO SCALE CONSTRUCTION JOINT COMPLETE JT PENETRATION OC ON CENTER CLR OD OUTSIDE DIAMETER CONTROLLED LOW OPPOSITE HAND STRENGTH MATERIALS OWSJ OPEN WEB STEEL JOIST CORRUGATED METAL PIPE CONCRETE MASONRY UNIT METAL PLATE COL COLUMN POWDER DRIVEN FASTENER CONC CONCRETE PRESS. TREATED DOUG. FIR CONN CONNECTION PLYWOOD CONSTRUCTION CONST PARTIAL JOINT PENETRATION CONT CONTINUOUS POUNDS PER SQUARE FOOT CSK COUNTERSINK PSI POUNDS PER SQUARE INCH POINT OR POST TENSION DOUBLE DEMAND CRITICAL WELD DCW RADIUS DET DETAIL REINF CONC PIPE RCP DOUGLAS FIR REINFORCED. REINFORCING REINF DIAGONAL REQ'D REQUIRED DOWN DRAWING S.A.D. SEE ARCH. DRAWINGS SCHED SCHEDULE (E) **EXISTING** SFRS SEISMIC FORCE RESISTING SYSTEM EΑ EACH SHT SHEET EDGE FASTENING SHTG SHEATHING **ELEVATION** SIM SIMILAR ELEVATOR SM SHEETMETAL EΝ EDGE NAILING SMS SHEET METAL SCREW EQ EQUAL SPEC(S) SPECIFICATION(S) EACH WAY ΕW SQUARE STD STANDARD FG FINISH(ED) GRADE STS SELF TAPPING SCREW FINISH(ED) SYM SYMMETRICAL FOUNDATION FACE OF CONCRETE TONGUE AND GROOVE FS FAR SIDE TBR TO BE REMOVED FTG FOOTING T.O. TOP OF TOF TOP OF FOOTING Ga GAUGE T.O.P. TOP OF PLATE GALVANIZED TOP OF SLAB OR STEEL GLUED LAMINATED BEAM TOP OF STEM WALL TOSW **HEXAGONAL** TOP OF WALL TYP TYPICAL HANGER HORIZ HORIZONTAL HIGH STRENGTH BOLT UON UNLESS OTHERWISE NOTED HOLLOW STRUCT SECTION HEIGHT VERT VERTICAL

## NOTES

WIDE FLANGE

WATERPROOF OR WORK POINT WELDING PROCEDURE SPECS

ALL WORK SHALL CONFORM TO THE REQUIREMENTS OF THE CURRENT GOVERNING EDITION OF THE CALIFORNIA BUILDING CODE.

INTERNATIONAL BLDG CODE W/

INSIDE DIAMETER

INSPECTION/INSPECTOR

CONSTRUCTION LIABILITY

THE CONSTRUCTION CONTRACTOR AND HIS SUBCONTRACTORS AGREE THAT IN ACCORDANCE WITH GENERALLY ACCEPTED CONSTRUCTION PRACTICES, THE CONSTRUCTION CONTRACTOR AND HIS SUBCONTRACTORS WILL BE REQUIRED TO ASSUME SOLE AND COMPLETE RESPONSIBILITY FOR JOB SITE CONDITIONS DURING THE COURSE OF CONSTRUCTION OF THE PROJECT, INCLUDING SAFETY OF ALL PERSONS AND PROPERTY; AND THAT THIS REQUIREMENT SHALL BE MADE TO APPLY CONTINUOUSLY AND NOT LIMITED TO NORMAL WORKING HOURS. THE CONSTRUCTION CONTRACTOR AND HIS SUBCONTRACTORS FURTHER AGREE TO DEFEND, INDEMNIFY AND HOLD THE DESIGN PROFESSIONAL HARMLESS FROM ANY AND ALL LIABILITY, REAL OR ALLEGED, IN CONNECTION WITH THE PERFORMANCE OF WORK ON THIS PROJECT, EXCEPT LIABILITY ARISING FROM THE SOLE NEGLIGENCE OF THE DESIGN PROFESSIONAL.

SUBMITTALS FOR ENGINEER'S REVIEW WILL BE REQUIRED AS FOLLOWS:

A. PILE INSTALLATION PLAN B. STRUCTURAL STEEL SHOP DRAWINGS

CONTRACTOR MUST SUBMIT ELECTRONIC PDF SUBMITTALS FOR REVIEW. FABRICATION MUST NOT PROCEED UNTIL SUBMITTALS HAVE BEEN REVIEWED AND APPROVED BY THE ENGINEER.

# SPECIFICATIONS

ALL WORK SHALL CONFORM TO THE REQUIREMENTS OF THE CURRENT GOVERNING EDITION OF THE CALIFORNIA BUILDING CODE AND CALTRANS STANDARDS EXCEPT WHEERE NOTED BELOW.

CONCRETE SHALL BE CONSTRUCTED IN ACCORDANCE WITH ACI 301 & 318 - CURRENT EDITION. CONCRETE SHALL BE READY-MIXED CONCRETE IN ACCORDANCE WITH ASTM C94.

MAXIMUM WATER-CEMENT RATIO, BY WEIGHT SHALL BE AS FOLLOWS: 28 DAY COMPRESSIVE NON-AIR

ENTRAINED STRENGTH ENTRAINED 2500 PSI CONCRETE .62

AT THE CONTRACTOR'S OPTION, AN AIR ENTRAINING AGENT CONFORMING TO THE LATEST REVISION OF ASTM SPECIFICATION C260 MAY BE ADDED TO THE CONCRETE TO PROVIDE SPECIFIED AMOUNTS OF ENTRAINED AIR. CEMENT SHALL BE IN ACCORDANCE WITH THE STANDARD SPECIFICATIONS FOR PORTLAND CEMENT PER ASTM DESIGNATION C150, TYPE II.

SYMBOLS

VALLEY AVE SOUND WALL - SITE PLAN

VALLEY AVE SOUND WALL - DETAILS


VALLEY AVE SOUND WALL - SPECIFICATIONS AND NOTES

-SECTION LETTER OR DETAIL NUMBER -DRAWING NUMBER WHERE SECTION OR DETAIL IS DRAWN

DRAWING

**BIGGS CARDOSA ASSOCIATES INC** STRUCTURAL ENGINEERS

865 The Alameda San Jose, California 95126 408–296–5515

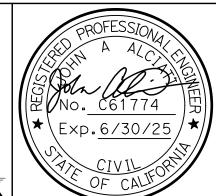

30			
SCALE:	۸ς	SHOW	/

)WG

REV.	DATE	DESCRIPTION
		REBID SET



CITY OF PLEASANTON PUBLIC WORKS DEPARTMENT ADAM M. NELKIE CITY ENGINEER NO. 78830 EXP. 9/30/25

VALLEY AVENUE SOUND WALL REPAIR PROJECT (REBID) VALLEY AVE SOUND WALL - SPECIFICATIONS AND NOTES

DESIGN: NBP DRAWN: SMH CHECKED: SH1 TRAFFIC ENGINEER:

SCALE: AS SHOWN PROJECT NO.: CIP-1843 DATE: 5/23/25

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