ADDENDUM NO. 2

NEAR-TERM WATER IMPORVEMENTS PROJECT NO. 24171 & 24173

This addendum is hereby made a part of the project contract documents. It shall be the responsibility of the general contractor to inform any affected sub-bidder of the content of this addendum.

The contract documents are modified/clarified as follows:

1. Bid Proposal

Replace the Bid Proposal with attached, revised Bid Proposal.

Bid Sheet has been revised to reflect changes from Addendum No. 1
Project 24171 – Item 21 Utility Potholes

Project 24173 - Item 1 Utility Potholes

And the following changes from this Addendum No. 2
Project 24173 – Item NOT USED

2. **Project 24171 Special Provision Section 2-01E Traffic Control Restrictions** *Add:*

Franklin Drive and Tom Burnett Lane can each be closed for pipe installation with detours for local traffic. One street must remain open at all times. Submit traffic control plans for City's review per Section 2-01D – Traffic Control Plan of the Special Provisions.

3. Project 24171 Special Provision Section 14-02B.2 12" Pressure Reducing and Surge Anticipator Valve

Replace "... pressure class 300..." with "... pressure class 150...".

4. Project 24171 Special Provision Section 14-02L City Supplied Materials Replace in its entirety with:

City is supplying 24" gate valve and blind flange only. No bolts are being supplied. City is not supplying any material for Turnout No. 4.

5. Project 24173 Special Provision Section 1-33A Bid Item Measurement and Payment Descriptions Bid Item No. 3 - 12-inch DIP (HDSS)

Item is deleted.

All 12-inch DIP (HDSS) is included in Bid Item No. 7.

6. Project 24171 Plan Sheet C-3

Add Note 3 to NOTES:

Install 1" polyethylene sensing line from pressure reducing valve to a 1" service tap on 18" DIP between 18"x16" cross/gate valve and 18"x 12" flushing tee. Place near gate valve. 1" tap per City Standard Drawing 301.

7. Project 24171 Plan Sheet C-5

Remove Construction Note No. 69 in its entirety.

8. Project 24171 Plan Sheet C-6

Replace Sheet with attached, revised Sheet C-6

Undercrossing Details 2 & 3 have been revised to clarify "TR Flex or HDSS pipe with TR Flex fittings or Approved Equals" are required.

9. Project 24173 Plan Sheet CD-8

Replace Sheet with attached, revised Sheet CD-8

Undercrossing Details 2 has been revised to clarify "TR Flex or HDSS pipe with TR Flex fittings or Approved Equals" are required.

Requests for Information:

10. Question: Will City consider butterfly valves in lieu of gate valves as height from

centerline of pipe to top of operating nut may conflict with desired

minimum pipe cover?

Answer: See City Standard Specification 14-02D – Valves and Special Provision

23-01K. Depth of pipe will be adjusted, if necessary, to accommodate

gate valves.

11. Question: Please confirm night work is required on Sunol Boulevard from STA

25+00 to 36+00 and STA 48+50 to 54+67.

Answer: Correct.

12. Question: For Project 24171 can the 18" gravity flushing line on Sheets C-3 and C-9

be connected to the barrel of the existing sewer manhole or is it

required to be connected to the base?

Answer: The profile of this line will be set after potholing. The intent is to place

this line as shallow as possible while maintaining required separations

to potable facilities and to enter the sewer manhole barrel.

13. **Question:** Please confirm laydown yards can be accessed at night for night work

operations.

Answer: Correct.

14. Question: Please confirm the existing vault and material covered under Note 12 on

Sheet C-1 is to be removed and disposed of per Addendum No. 1.

Answer: Correct.

15. **Question:** Please confirm there are no anodes required for Sunol Boulevard work

under Project 24173.

Answer: Correct.

16. **Question:** Under what Bid Item should the sump pump required for Project 24171

be included?

Answer: The cost of the sump pump shall be considered to be included in the

various Turnout Bid Item Nos. 11 through 19 and no separate payment

will be made.

17. Question: It appears for Project 24173 20-inch HDSS pipe is double counted under

Item No. 2 20-inch DIP (HDSS) and Lump Sum Item Nos. 4, 5, 6, and 8.

Please clarify.

Answer: Item No. 2 is a measured quantity and lengths paid under this item will

exclude lengths of pipe required for Item Nos. 4, 5, 6, and 8.

18. Question: For Project 24171, is there additional information available for the

PG&E tie-in work in terms of location of tie-in?

Answer: No, please refer to measurement and payment clauses for Bid Item No.

95.

All other items of work in the contract document remain unchanged. Acknowledgement and a

signed copy of this Addendum shall be included in the Bid Proposal.

END OF ADDENDUM NO. 2

BID PROPOSAL

Near-Term Water Improvements Project No. 24171 & 24173

DATE:	
Proposal of	(hereinafter called
"Bidder") a	organized and existing under the laws of the State
, doing business as	, to the City of Pleasanton, City Clerk,
123 Main Street, Pleasanton, Co	alifornia (hereinafter called "City").
Ladies and Gentlemen:	
IMPROVEMENTS, PROJECT NO and Specifications and related of familiar with all of the condition the availability of materials and with any other person, firm or owith the contract documents, v	the invitation for bids for the NEAR-TERM WATER 9. 24171 & 24173, City of Pleasanton, having examined the Plans documents and the premises of the proposed work, and being as surrounding the construction of the proposed project including a supplies, declares that this proposal is made without collusion corporation and agrees to construct the project in accordance within the time set forth therein, and at the prices stated below. penses incurred in performing the work required under the this Bid Proposal is a part.
Work Completion	•
Bidder shall complete all work	designated as Phase 1 by June 30, 2024. designated as Phase 2 within one-hundred-and-ten (110) working
booster station fabrication and notification. Notification is exp	Notice to Proceed" to start Phase 3 dependent on prepacked shall commence work within fifteen (15) calendar days of sected to be given between February and May, 2025. designated as Phase 3 within sixty (60) working days after start of
For Project No. 24173:	

Liquidated Damages

start of work.

For Project No. 24171:

Bidder shall pay as liquidated damages in the sum of **\$2,000** per calendar day should the successful bidder fail to complete the work designated as Phase 1 by June 30, 2024.

Bidder shall complete all work within one-hundred-and-seventy (170) working days after the

Bidder shall pay as liquidated damages in the sum of \$4,500 per calendar day should the successful bidder fail to complete the work designated as Phase 2 within one hundred ten (110) working days.

Bidder shall pay as liquidated damages in the sum of \$2,000 per calendar day should the successful bidder fail to complete the work designated as Phase 3 within sixty (60) working days.

For Project No. 24173:

Bidder shall pay as liquidated damages in the sum of \$4,500 per calendar day should the successful bidder fail to complete the work within one hundred seventy (170) working days.

Liquidated damages will accrue separately and are additive for failure to complete the work or phases of work within the above time limits.

Bidder acknowledges receipt of the following addendum:

No.	<u>Date</u>	<u>No.</u>	<u>Date</u>
		=	
	5	-	
	<u> </u>	<u> </u>	=
	= - 8		-
		¥	

Bidder to perform all of the work described in the Contract Documents for the total bid amount entered.

Bid Table on Next Page

Project No. 24171

			Project No. 24171		
Item No.	Quantity (Approximate)	Unit of Measure	Item Description	Unit Price	Total
1	1	LS	Mobilization		
2	1	LS	Traffic Control		
3	1	LS	Site Demolition, Finished Site Work and Grading		
4	1	LS	Trench Shoring		
5	1	LS	Zone 7 Connection		
			Turnout 9' x 13' Precast Concrete		
6	1	EA	Vault with Access Hatch		
			8" Sch 40 PVC Vent Pipe and		
7	1	EA	Fittings with 2' Cover		
			12" Diameter x 36" High Armorcast		
8	1	EA	Standpipe Vent with 24 Vent Slots,		
	_	LA	Model P6002712, or equal		
		LS	Concrete Slab for Package Pump		
9	1	LJ	Station – Size and Reinforcement		
9	1		per Foundation Plan		
			Fluoride Improvements (New 500-		
10	_	1.6	gallon Fluoride Chemical Tank and		
10	1	1 LS	Fittings, Containment Curb		
			Modifications, New Fluoride Vault,		
11	2	ГА	and Removal of Old Equipment)		
11	2	EA	14" FLG x PE DI Spool		
12	1	EA	14" FLG x FLG Gate Valve		
4.0	_		Rosemount Model 8712E Pressure		
13	2	EA	Transmitter with 125/150 FLG		
			Drilling		
14 1		EA	14" FLG x FLG Rosemount Flow		
			Meter, Model 8705 14" Dezurik VPB V-Port Ball Valve		
			I		
15	1	ГЛ	with ANSI 150 Flanges, Rotork		
15	1	EA	Electric Motor, and Operator		
			IQTM2000 Modulating 480 Vac		
1.0	1	ГА	Main Voltage		
16	1	EA	14" FLG x FLG DI Spool		
17	1	EA	Water Sampling Tap		
4.0		F.4	14" Dismantling Joint, Romac		
18	1	EA	Model DJ400 or Equal with Tie		
			Rods		
4.0		F.	14" Combination Pressure		
19	1	EA	Reducing Check Valve, Cla-Val		
			Model 94-01		
20	3,200	LF	24" C900 DR18 (Class 235) FPVC		
			Discharge Piping		
21	60	EA	Utility Potholes		

Item No.	Quantity (Approximate)	Unit of Measure	Item Description	Unit Price	Total
22	210	LF	18" DIP, Class 350		
23	200	LF	16" DIP, Class 350		
24	35	LF	24" DIP, Class 350		
25	1	EA	6" Gate Valve, FLG x MJ		
26	2	EA	12" Gate Valve, FLG x FLG		
27	2	EA	12" Gate Valve, FLG x RMJ		
28	2	EA	16" Gate Valve, FLG x MJ		
29	2	EA	16" Gate Valve, FLG x RMJ		
30	4	EA	18" Gate Valve, FLG x RMJ		
31	1	EA	Install City Furnished 24" Gate Valve, FLG x RMJ		
32	1	EA	24" x 16" DIP Reducer, FLG x MJ		
33	1	EA	12" x 6" DIP Reducer		
34	1	EA	16" x 14" FLG x FLG DI Concentric Reducer with MJ Restraint for DIP,		
34	1	EA	EBAA Iron Series 1100 or Equal		
35	1 01x	EA	18" x 14" FLG x FLG DI Concentric Reducer with MJ Restraint for DIP, EBAA Iron Series 1100 or Equal		
36	2	EA	24" x 12" FLG x FLG DIP Reducer		
37	1	EA	24" x 16" DIP Reducer FLG x FLG		
38	1	EA	24" x 18" DIP Reducer FLG x FLG		
39	4	EA	16" Res Solid Sleeve		
40	3	EA	12" Transition Coupling		
41	1	EA	12" MJ DI 45° Elbow with MJ Restraint for DIP, EBAA Iron Series 1100 or Equal		
42	1	EA	16" 45° Elbow, FLG x FLG		
43	1	EA	18" MJ DI 45° Elbow with MJ Restraint for DIP, EBAA Iron Series 1100 or Equal		
44	1	EA	18" MJ DI 90° Elbow with MJ Restraint for DIP, EBAA Iron Series 1100 or Equal		
45	2	EA	18" DI 45° Elbow RMJ		
46	1	EA	18" FLG x MJ DI 45° Elbow with MJ Restraint for DIP, EBAA Iron Series 1100 or Equal		
47	3	EA	24" DI 45° Elbow FLG		
48	4	EA	24" DI 11.25° Elbow RMJ		
49	1	EA	18" x 12" Tee FLG		
50	2	EA	16" Tee FLG x FLG x RMJ		
51	1	EA	16" x 16" x 12" Tee with Blind Flange		

Item No.	Quantity (Approximate)	Unit of Measure	Item Description	Unit Price	Total
52	1	EA	24" Tee FLG		
53	1	EA	24" x 12" MJ x FLG Tee		
54	1	EA	24" DIP Cross		
55	1	EA	18" x 16" DIP Cross		
56	1	EA	18" x 12" DIP Cross		
57	1	EA	12" FL x PE 5' Spool		
58	1	EA	12" FLG x PE Spool with Transition CPLG		
59	1	EA	16" FCA ACP OD		
60	4	EA	16" Solid Sleeve RMJ		
61	3	EA	16" FLG x PE DI Spool		
62	2	EA	12' DI Spool 5'		
63	1	EA	16" DI Spool 8'		
64	1	EA	16" DI Spool 3'		
65	4	EA	16" FLG x MJ Adapter		
66	3	EA	18" DIP Spools – var. lengths		
67	1	EA	18" FLG x PE Spool – 2'		
68	1	EA	24" FLG x MJ Adapter		
69	5	EA	2" Combination Air Valve Assembly		
70	1	EA	Fire Hydrant Assembly per City Std. No 307		
71	3	EA	Pipe Supports		
72	1	LS	Jack and Bore Crossing (including 24" FPVC installed, 42" Steel Casing, and Jacking and Receiving Shafts pipe and fittings)		
73			Not used		
74	1	LS	Striping/Markings		
75	1	LS	Water Main Abandonment		
76	1	LS	Remove Pipe		
77	1	LS	BMPs/Storm Water Pollution Control Plan		
78	12	EA	Cathodic Test Stations		
79	41	EA	30# or 18# Anode Bags		
80	1	LS	Flushing Station (Gooseneck and Inlet Box)		
81	1	LS	Install Package Booster Pump Station Furnished by Supplier		
82	1000	LF	24" FPVC Vertical Depth Adjustments (0FT to 2FT)		
83	100	LF	24" FPVC Vertical Depth Adjustments (2FT to 4FT)		
84	10	LF	24" FPVC Vertical Depth Adjustments (4FT to 6FT)		

Item No.	Quantity (Approximate)	Unit of Measure	Item Description	Unit Price	Total
85	10	LF	24" FPVC Vertical Depth Adjustments (6FT to 8FT)		
86	100	LF	18" DIP Vertical Depth Adjustments (OFT to 2FT)		
87	50	LF	18" DIP Vertical Depth Adjustments (2FT to 4FT)		
88	10	LF	18" DIP Vertical Depth Adjustments (4FT to 6FT)		
89	10	LF	18" DIP Vertical Depth Adjustments (6FT to 8FT)		
90	75	LF	16" DIP Vertical Depth Adjustments (0FT to 2FT)		
91	10	LF	16" DIP Vertical Depth Adjustments (2FT to 4FT)		
92	10	LF	16" DIP Vertical Depth Adjustments (4FT to 6FT)		
93	10	LF	16" DIP Vertical Depth Adjustments (6FT to 8FT)		
94	1	LS	Electrical System		
95	250	LF	PG&E Conduit from transformer to PG&E Tie-In. two 3" conduit and one pull box		

Project No. 24173

Item	Item Description		Unit Price	Total	
No.	(Approximate)	Measure	·		
1	40	EA	UTILITY POTHOLES		
2	4468	LF	20-inch DIP (HDSS)		
3			NOT USED		
4	1	LS	Sta 10+00.00 TIE-IN		
5	1	LS	Sta 15+34.15 60" CMP SD CROSSING		
6	1	LS	Sta 30+00.00 BORE AND JACK CASING AND CARRIER PIPE		
7	1	LS	Sta 50+76.23 FLUSHING CONNECTION		
8	1	LS	Sta 54+67.86 TIE-IN		
9	2	EA	12" GATE VALVE		
10	5	EA	20" GATE VALVE		
11	2	EA	20" DIP 22.5° FITTING		
12	4	EA	20" DIP 11.25° FITTING		
13	2	EA	20" X 8" DIP TEE FITTING		
14	3	EA	COMBINATION AIR VALVE		
15	4	EA	CP TEST STATION		
16	300	LF	VERTICAL DEPTH ADJUSTMENTS (OFT TO 2FT)		
17	100	LF	VERTICAL DEPTH ADJUSTMENTS (2FT TO 4FT)		
18	10	LF	VERTICAL DEPTH ADJUSTMENTS (4FT TO 6FT)		
19	10	LF	VERTICAL DEPTH ADJUSTMENTS (6FT TO 8FT)		
20	1	LS	STRIPING/MARKINGS		
21	1	LS	TRAFFIC CONTROL PLAN		
22	1	LS	BMP's/STORM WATER POLLUTION CONTROL PLAN		
23	1	LS	TRENCH SHORING		
TOTAL \$					

Note: The Bidder acknowledges that the total amount set forth above is for the entire project as represented by the Contract Documents regardless of itemization. Basis of bid comparison will be the Total Bid Amount.

Attached is a bid guaranty bond duly completed by a guaranty company authorized to carry on business in the State of California in the amount of at least ten percent (10%) of the total amount of the bid, or alternately, there is attached a certified or cashier's check payable to the City in the amount of at least ten percent (10%) of the total amount of the bid.

If this Bid Proposal is accepted, bidder agrees to sign the contract and to furnish the performance bond, labor and materials bond, maintenance bond, and the required evidences of insurance within ten (10) working days after receiving written notice of the award of the contract. If bidder fails to contract as provided herein or fails to provide the bonds and/or evidence of insurance, the City may at its option, determine the acceptance thereof shall be null and void, and the forfeiture of such security accompanying this Bid Proposal shall operate and the same shall be the property of the City of Pleasanton.


This Bid Proposal shall be good and may not be modified, withdrawn or canceled for a period of ninety (90) calendar days after the date of the City's opening of bids.


Bidder hereby certifies that the licensing information hereinafter stated is true and correct. Bidder further agrees, if the bid is accepted and a contract for performance of the work is entered into with the City, to so plan work and to prosecute it with such diligence that the work shall be completed within the time stipulated in the agreement. Under the penalty of perjury bidder affirms that, to the best of bidder's knowledge, the representations made in this bid are true.

Bidders are required by law to be licensed and regulated by the contractors' State License Board. Any questions concerning a contractor may be referred to the Registrar, Contractors' State License Board.


It is a misdemeanor for any person to submit a bid to a public agency in order to engage in the business or act in the capacity of a contractor within this state without having a license therefor, except for specific cases outlined in Business and Professions Code, Section 7028.15.

Name of Bidder	Contractor's License Number
Signature of Bidder	Expiration Date
Print Name	Address of Bidder
Title of Signatory	
State of Incorporation	() Telephone Number
DIR Registration Number	Contractor's Email Address

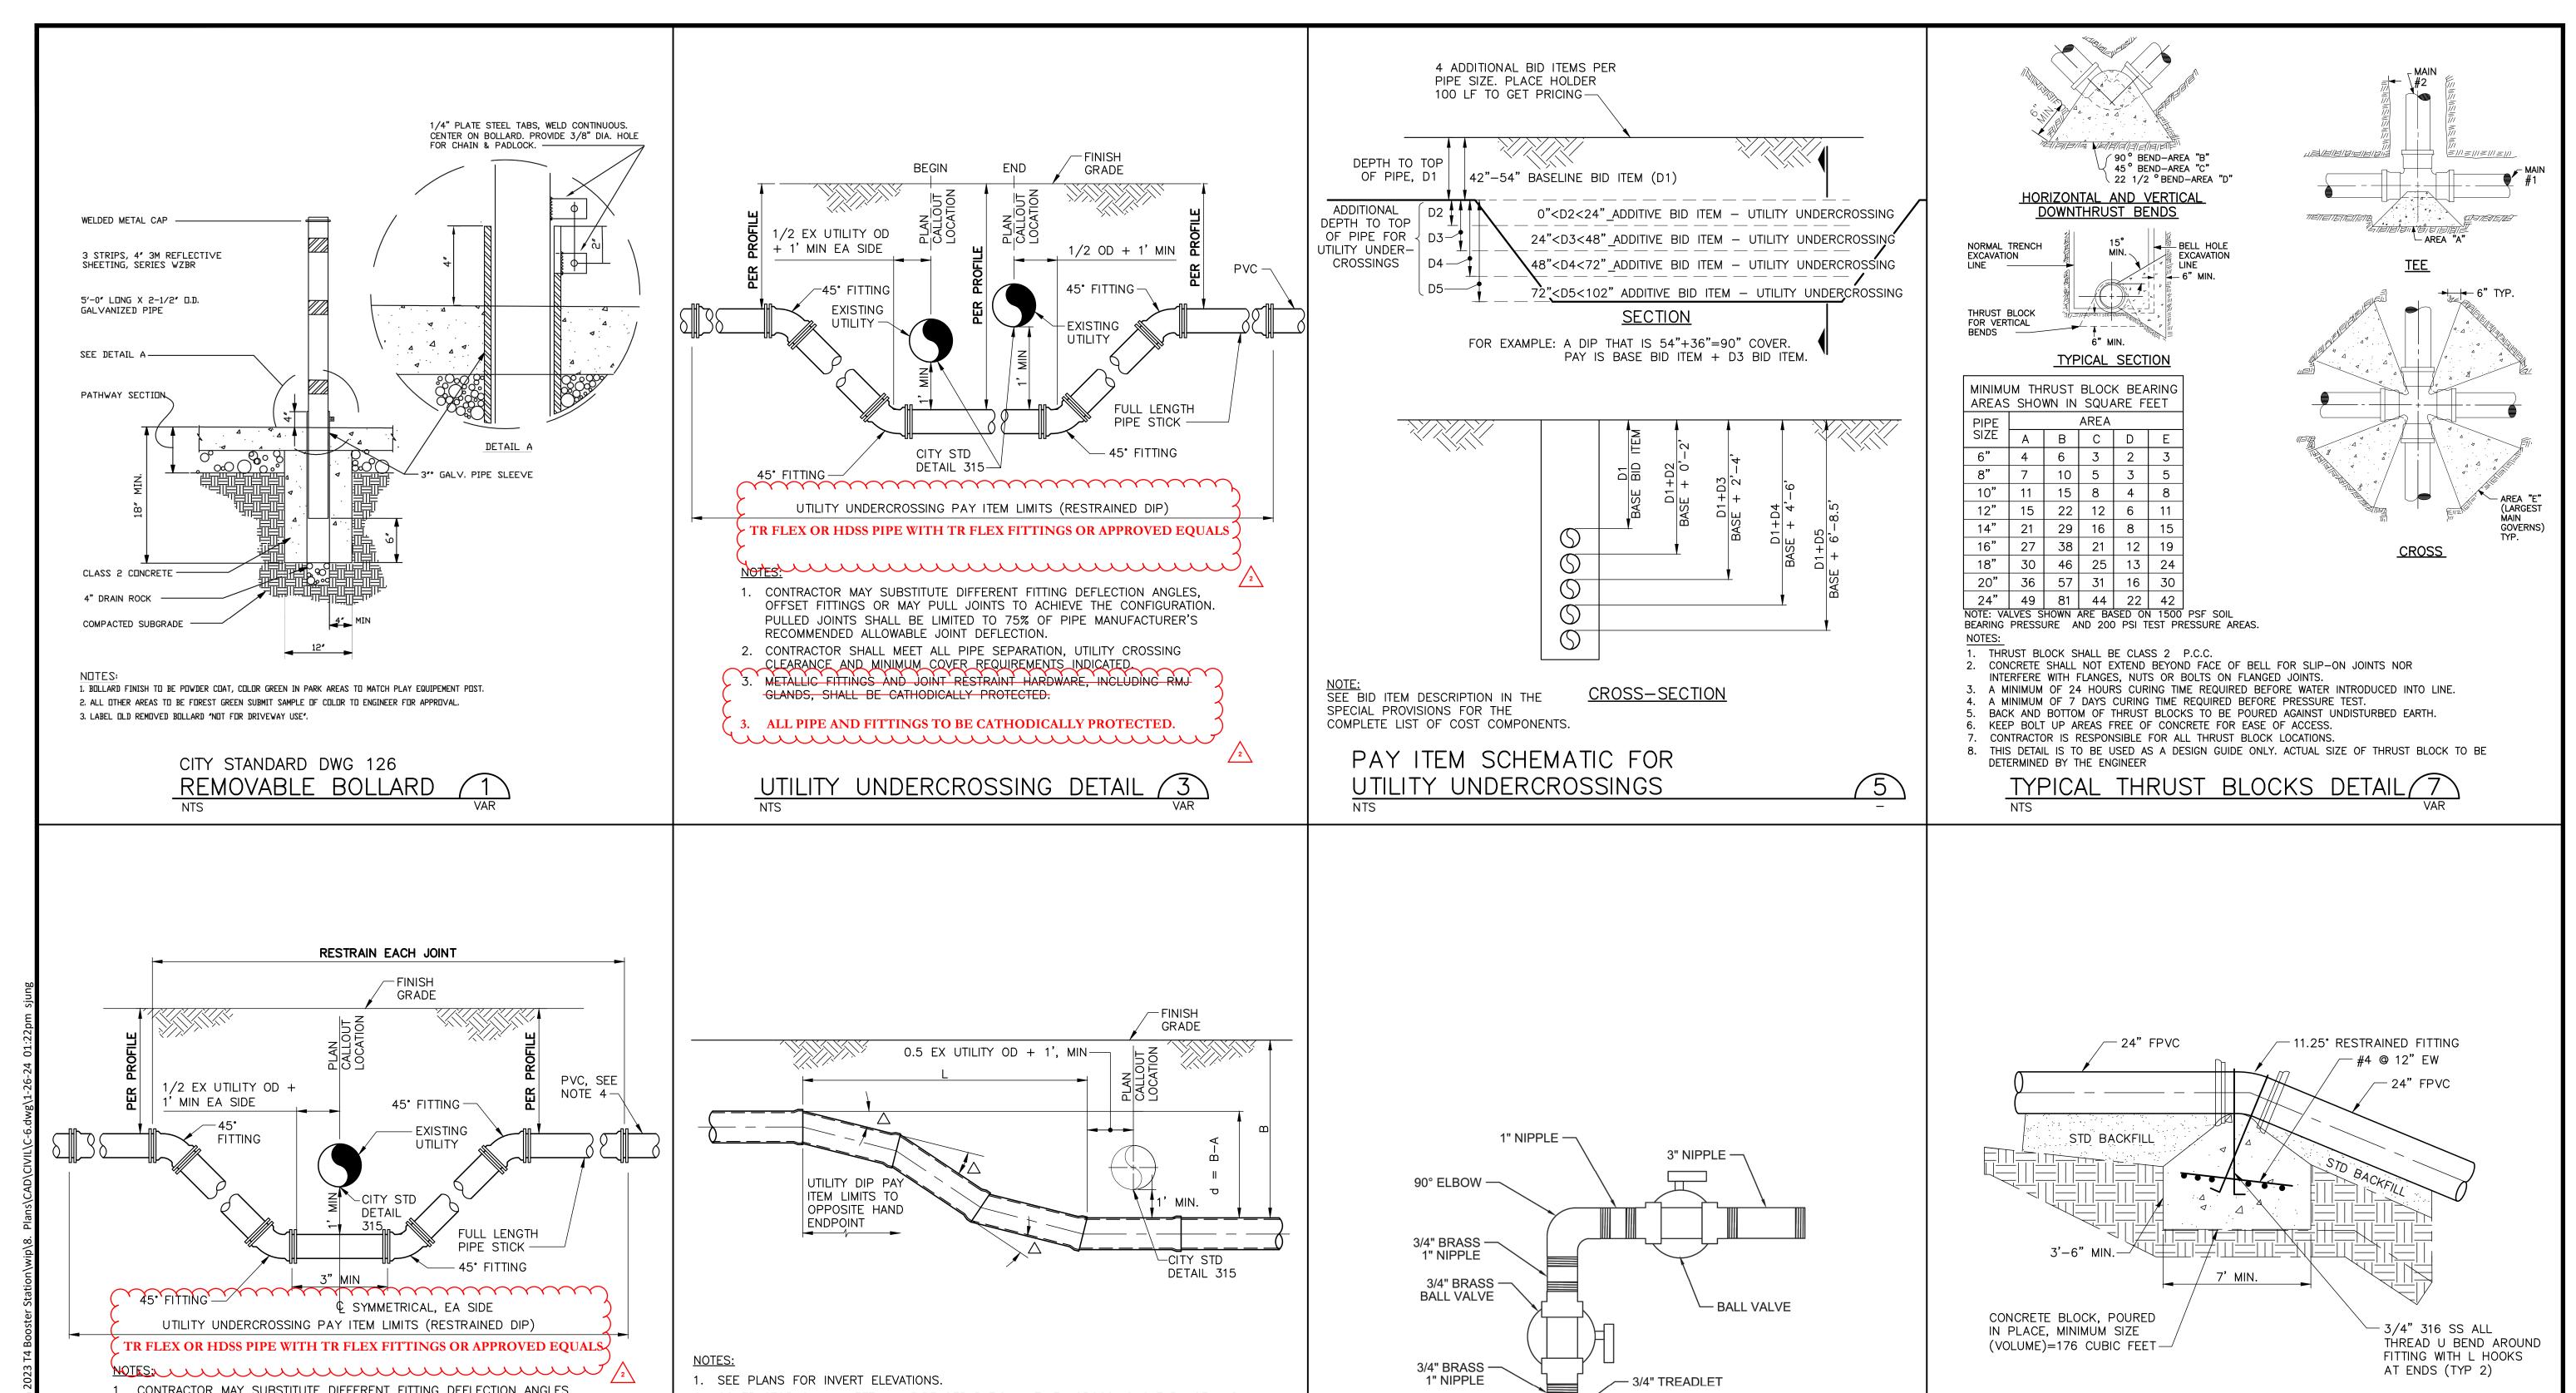

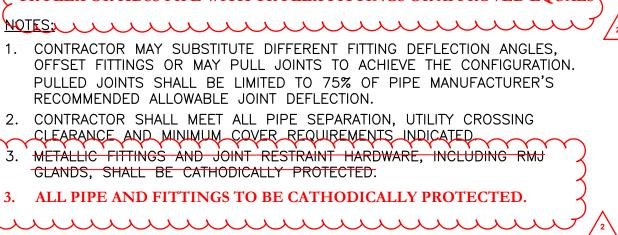

UTILITY UNDERCROSSING DETAIL

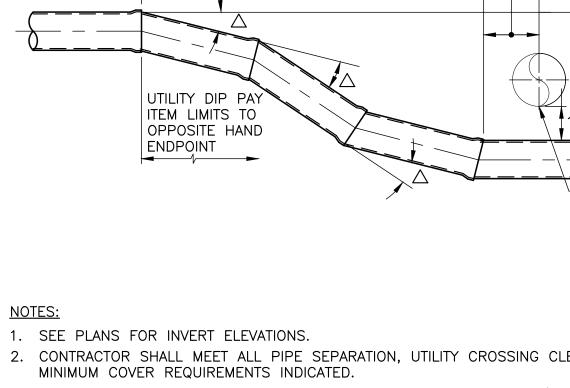


- 2. CONTRACTOR SHALL MEET ALL PIPE SEPARATION, UTILITY CROSSING CLEARANCE AND
- 3. PULLED JOINTS SHALL BE LIMITED TO 75% OF PIPE MANUFACTURER'S RECOMMENDED ALLOWABLE JOINT DEFLECTION.
- 4. ASSUMES MAXIMUM JOINT DEFLECTION SHOWN. VERIFY WITH PIPE MANUFACTURER.


5. ASSUMES FULL 20 FT PVC OR DIP PIPE SECTION LENGTHS.

UTILITY UNDERCROSSING DETAIL

NTS

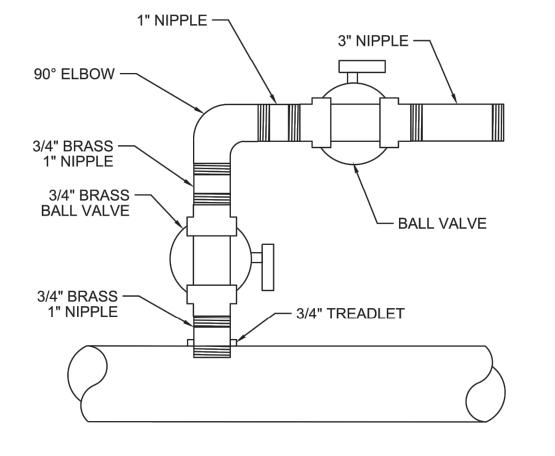

3/4" WATER SAMPLING TAP DETAIL 6

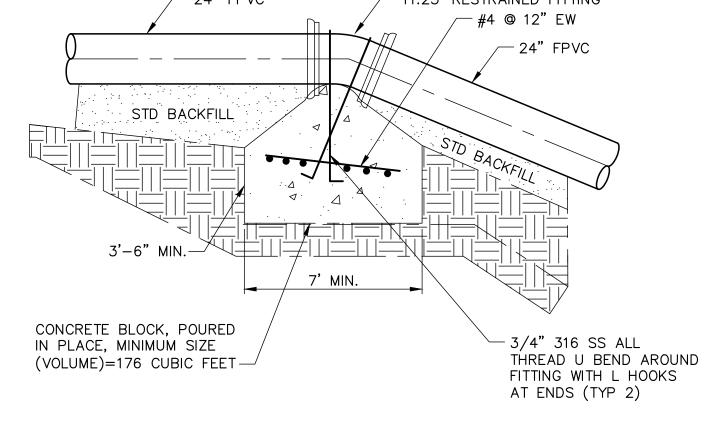

MIN. 4" COVER FOR ALL REINFORCEMENT

REVERSE THRUST BLOCK (GRAVITY THRUST BLOCK) (8



DWG NO.

C-6

15 OF 40

REV.	DATE	DESCRIPTION
A	01/26/24	ISSUE FOR BID
2	02/14/24	ADDENDUM NO. 2





CITY OF PLEASANTON PLEASANTON. PUBLIC WORKS DEPARTMENT



TURNOUT #4 BOOSTER PUMP STATION AND DISCHARGE PIPELINE (F-1 LINE) CIVIL DETAILS 2 - UTILITY CROSSING AND THRUST BLOCK DETAILS

DESIGN:	JS	SCALE:		1"=6'
DRAWN:	SJ	PROJECT N	NO ·	CIP-24171
CHECKED:	MM	I KOJLCI I	· · · · · · · · · · · · · · · · · · ·	C11 -2-1/1
		DATE:	JAN	UARY 2024

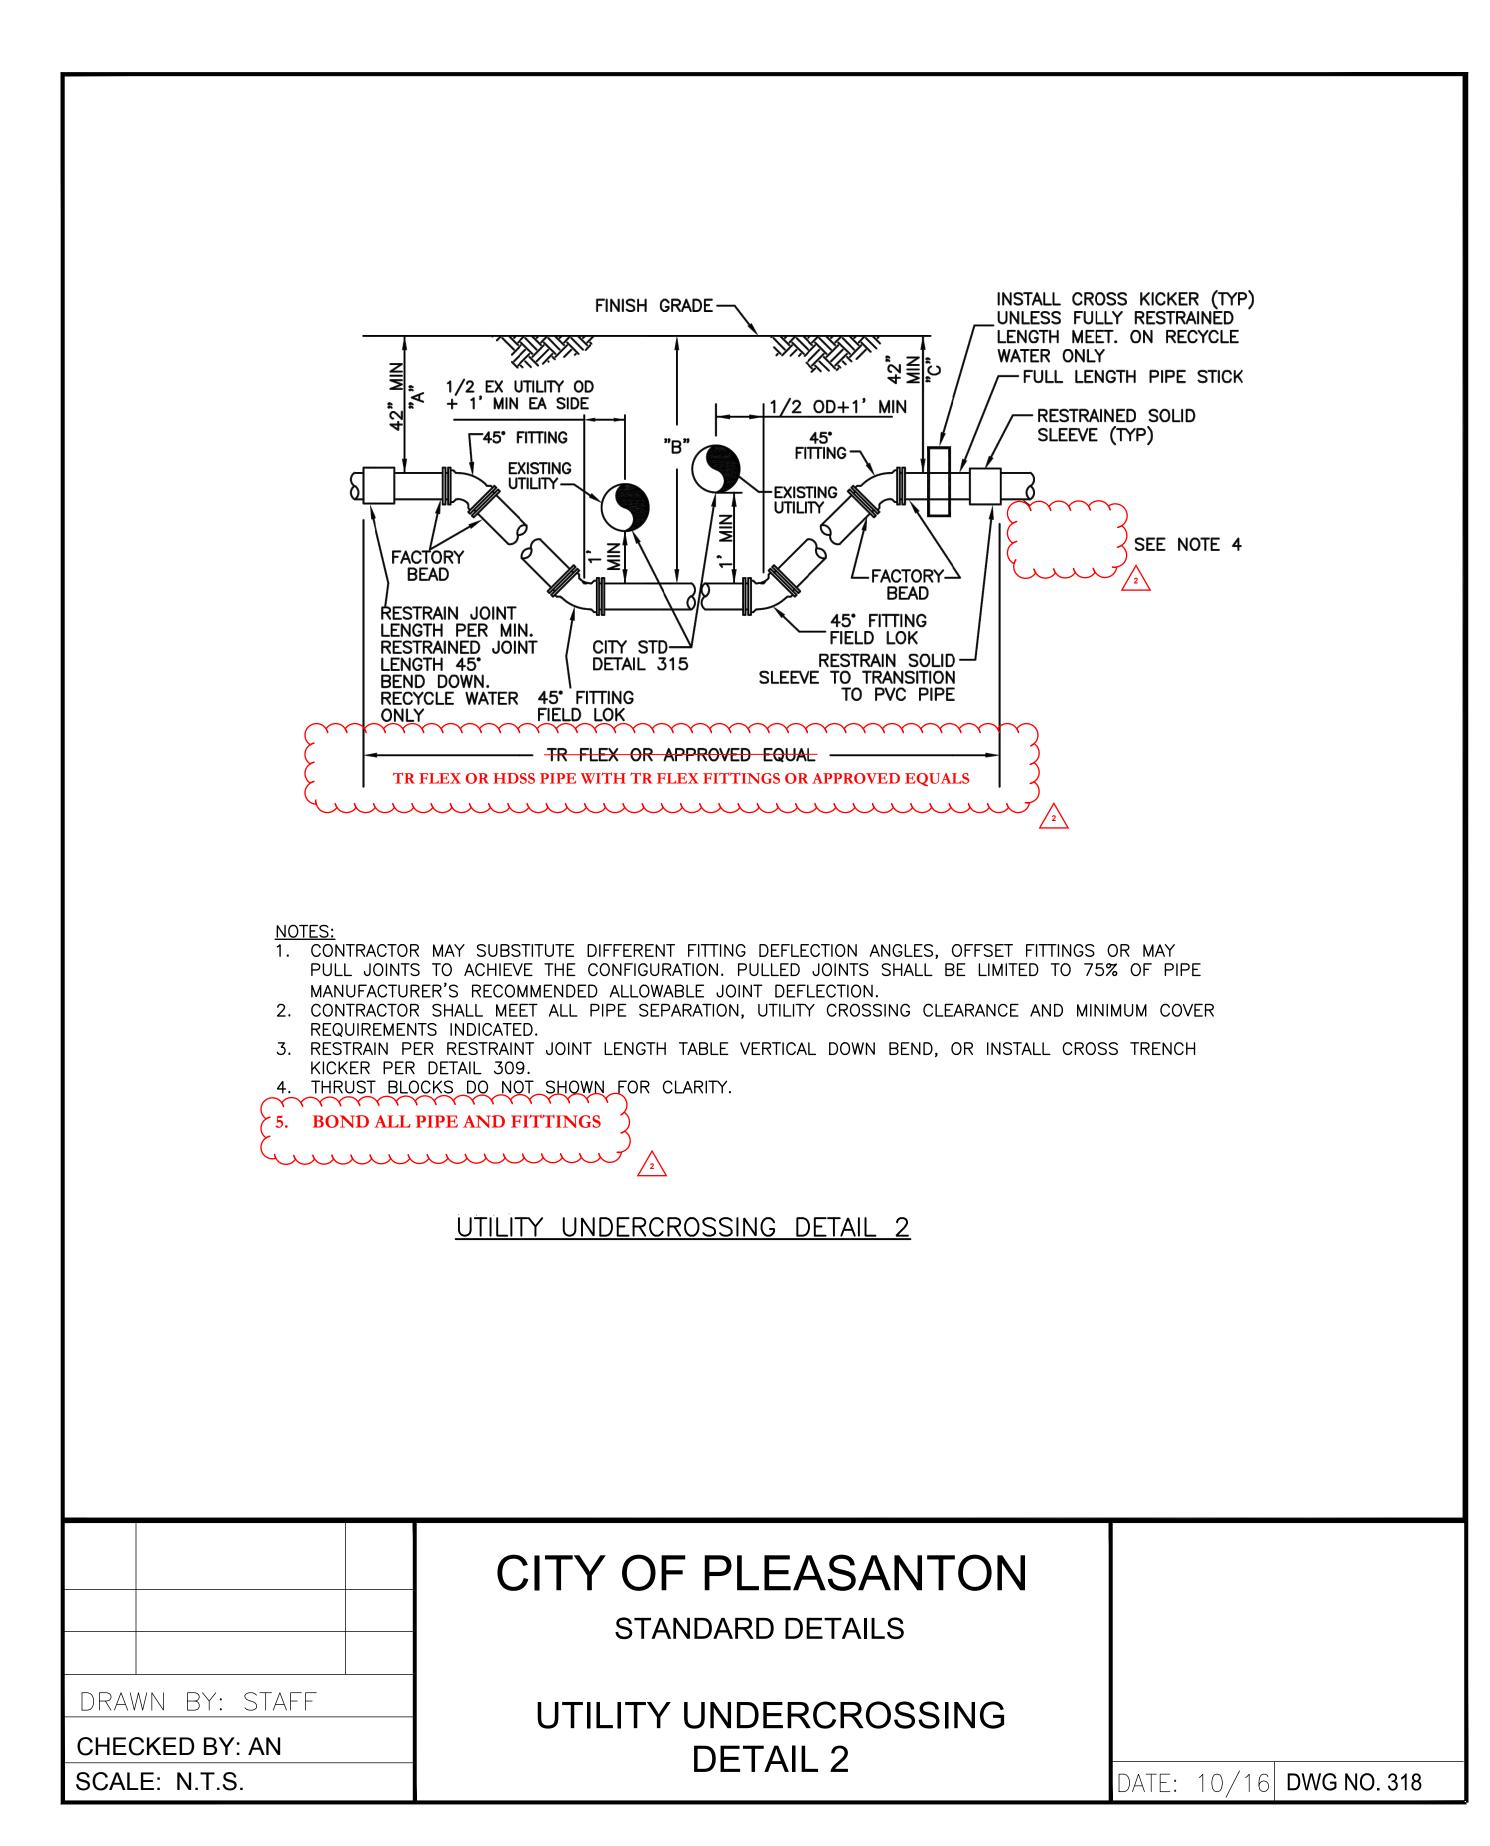

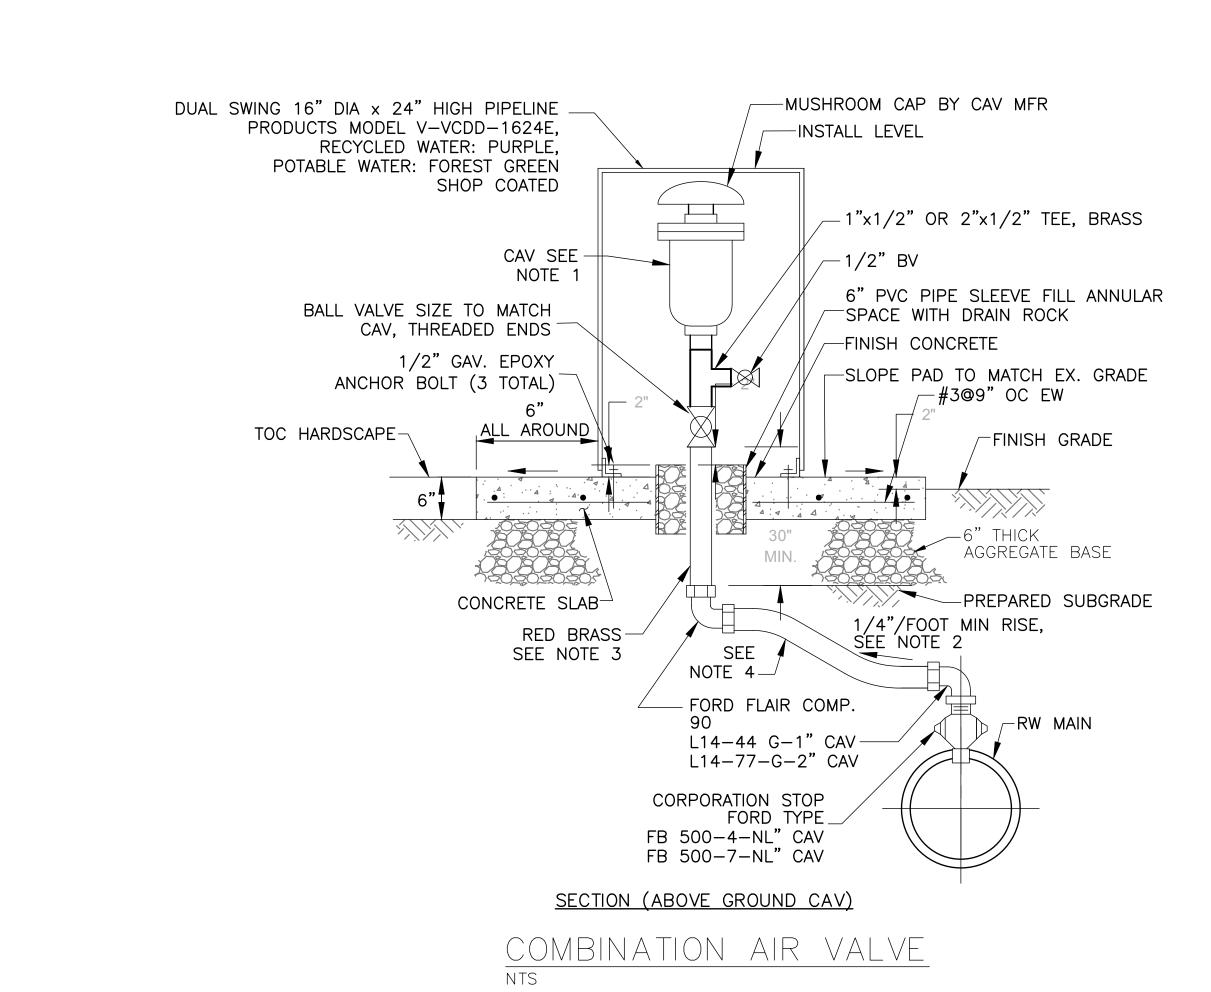

- 1. CAV SHALL BE APCO 143C FOR 1"TUBING AND APCO 145C FOR 2" TUBING, OR APPROVED EQUAL.
- 2. SERVICE LINE SHALL BE RUN IN A STRAIGHT LINE PERPENDICULAR TO PROPERTY LINE FROM MAIN TO PROPERTY LINE AND HAVE POSITIVE SLOPE.

3. 1" RED BRASS FOR 1" CAV. 2" RED BRASS FOR 2" CAV.

- 4. POLYETHYLENE TUBING SHALL CONFORM TO A.S.T.M. D-2737 & AWWAC-901 WITH A PRESSURE RATING OF 200 PSI AND SHALL BE "INTERSTATE POLY TUBING" OR APPROVED EQUAL. PURPLE TUBING FOR RECYCLE WATER.
- 5. WARNING TAPE MARKED "CAUTION RECYCLED WATER LINE BURIED BELOW" OR "PORTABLE WATER" SHALL BE INSTALLED 12" ABOVE THE WATER SERVICE.


6. TAPS FOR 2" REQUIRE A SADDLE.

7. 4" BEHIND CURB - WHERE PLANTER AREA EXISTS BETWEEN CURB AND SIDEWALK,

4" BEHIND SIDEWALK - WHERE SIDEWALK IS MONOLITHIC TO CURB.

8. FIELD COAT CAV AND ENCLOSURE W/12 MILS DFT AMINE CURED EPOXY, AMERCOAT 395 OR EQUAL. RECYCLED WATER COLOR: PURPLE PANTONE 512. POTABLE WATER COLOR: FOREST GREEN.

9. SEE PLANS FOR GENERAL PLACEMENT LOCATIONS.

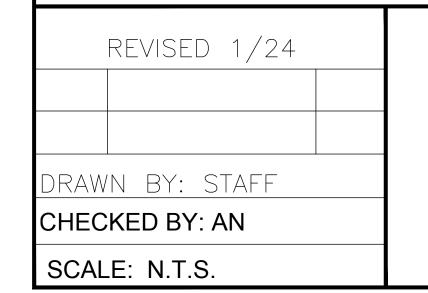

CITY OF PLEASANTON

MODIFIED STANDARD DETAIL

COMBINATION AIR - VACUUM RELEASE VALVE ASSEMBLY

DATE: 1/24 DWG NO. 312

DATE DESCRIPTION ADDENDUM NO. 2



CITY OF PLEASANTON PLEASANTON. PUBLIC WORKS DEPARTMENT



CONSTRUCTION DETAILS

DESIGN:	JLS	SCALE:	AS SHOWN
DRAWN:	MC	PROJECT NO.:	CIP_2//173
CHECKED:		TROJECT NO	CII -241/3
TRAFFIC ENGINEER:		DATE:	01/26/2024

DWG NO. **CD-8**